


**1 FLOOR PLAN**  
 SCALE: 1" = 20'-0"

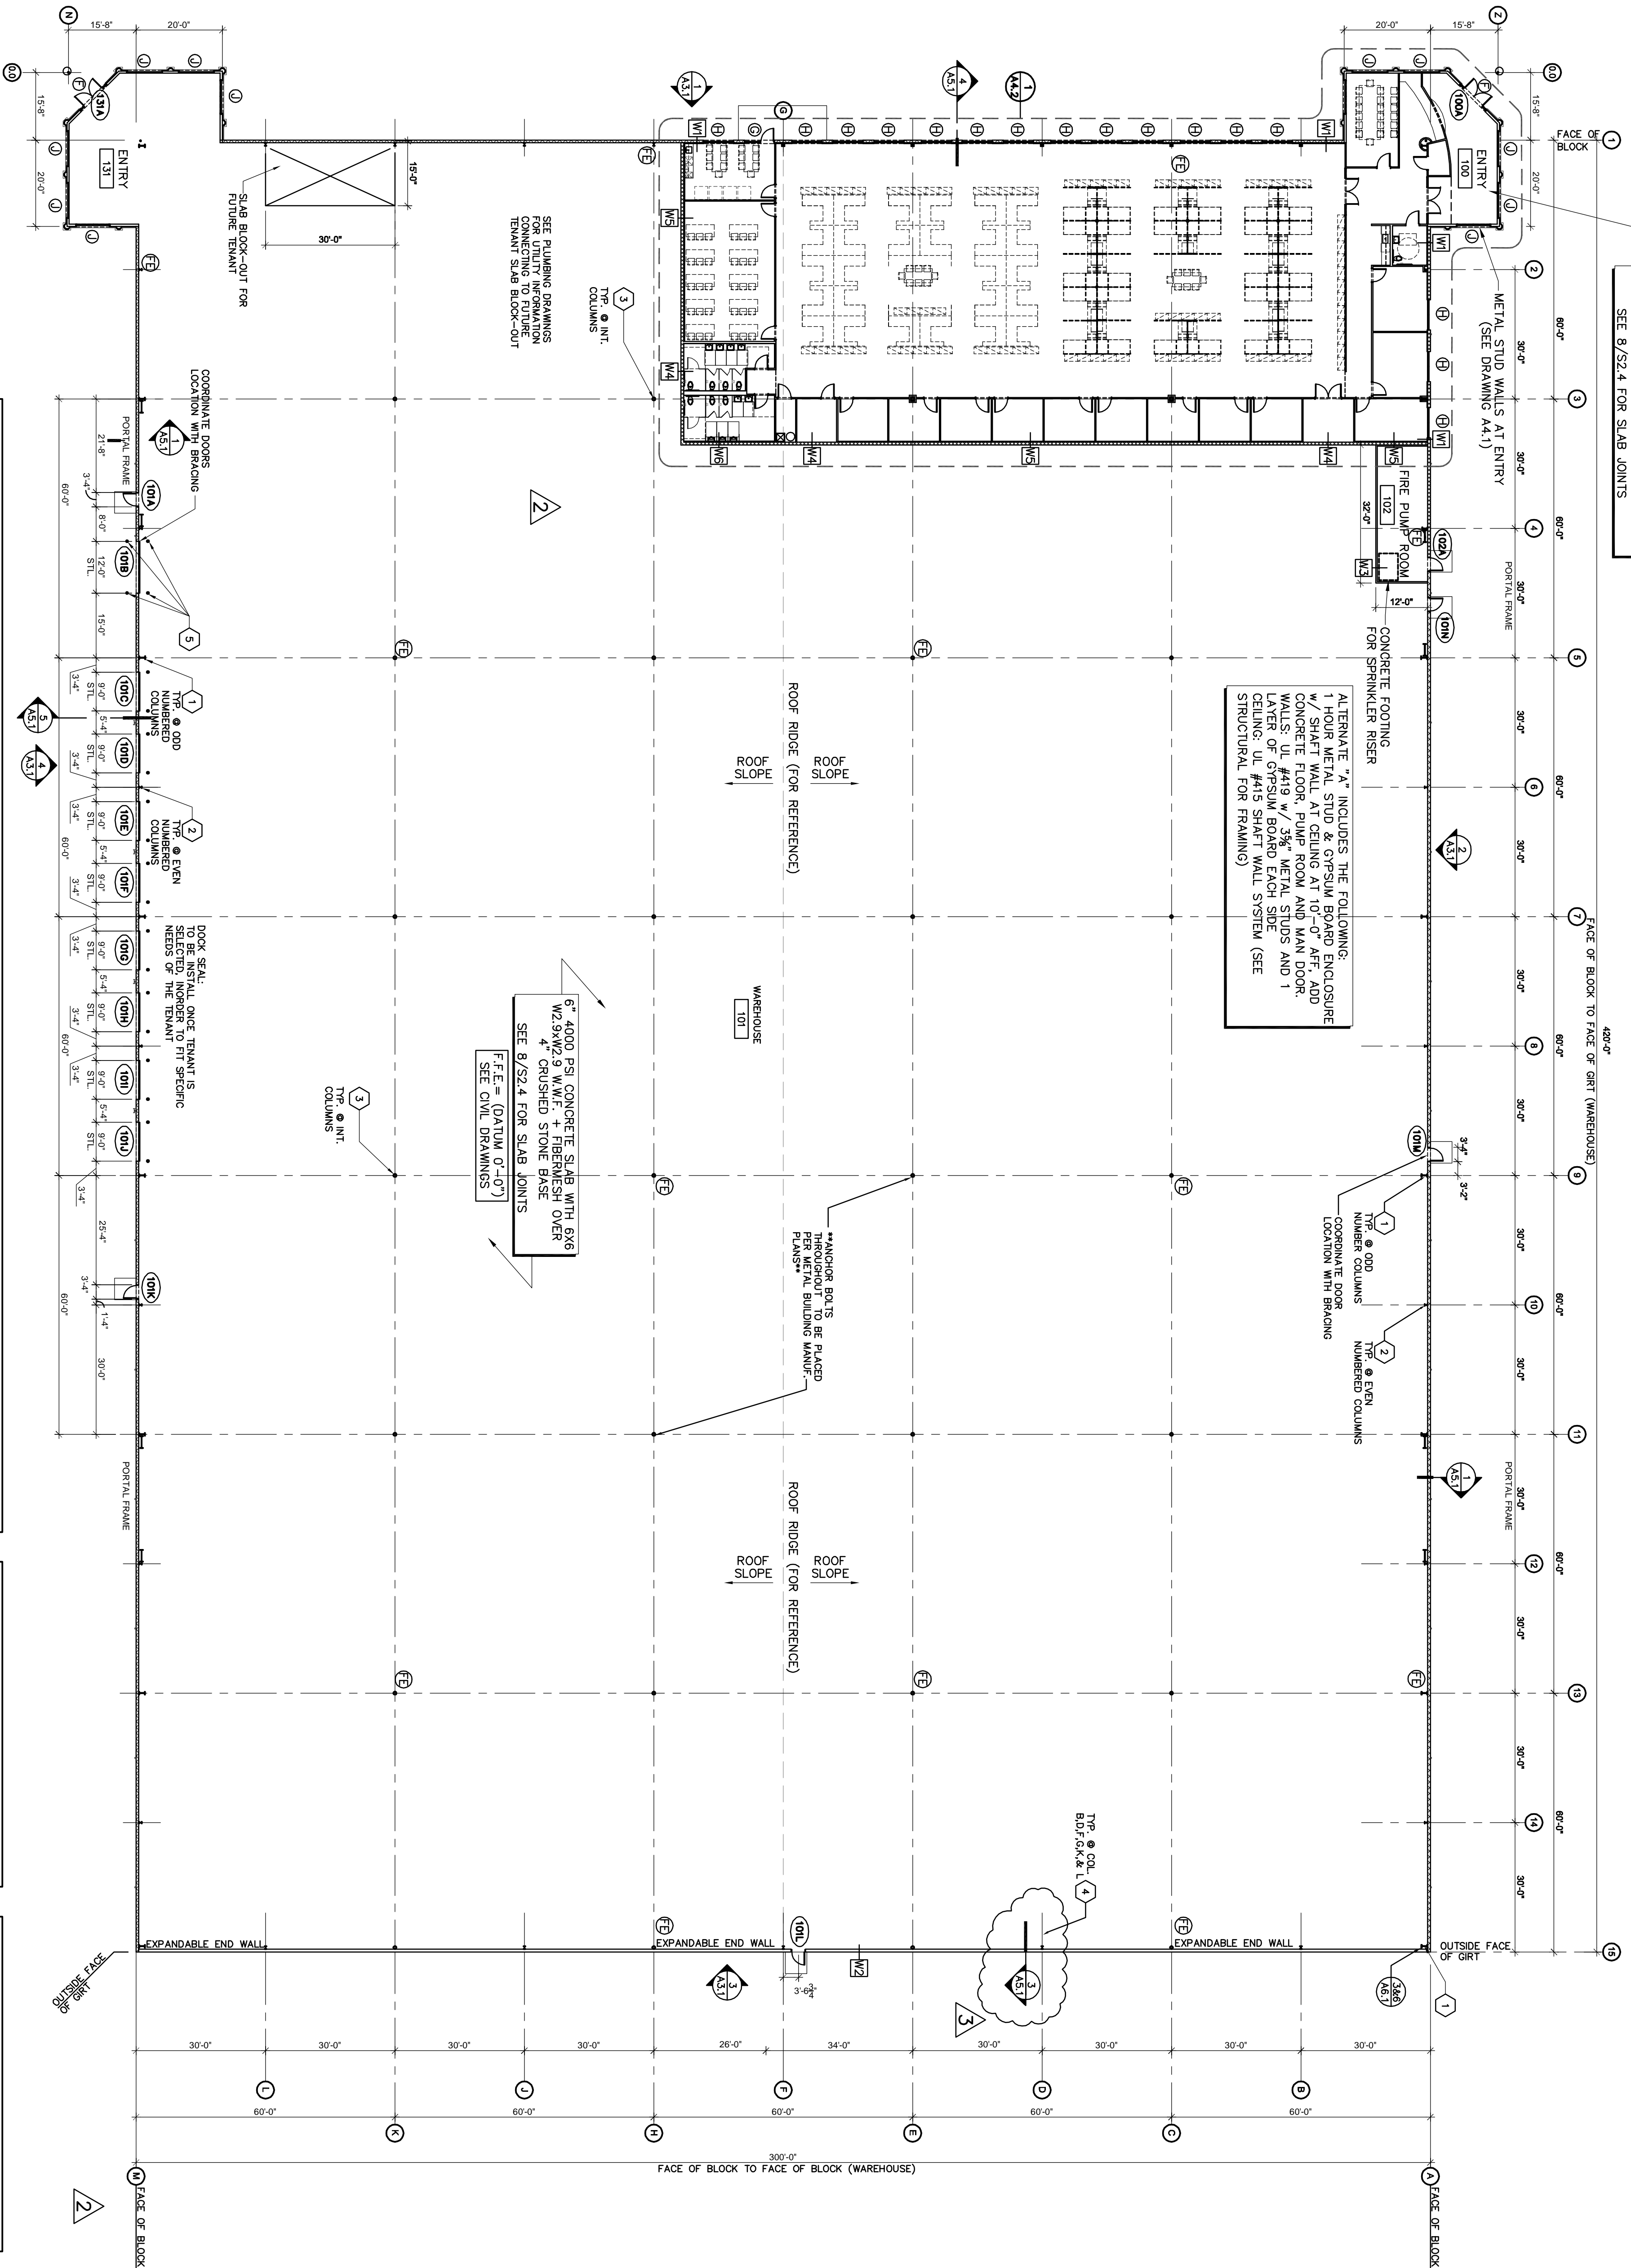

4" 4000 PSI CONCRETE SLAB WITH 6X6 W/2.9W/2.9 W.W.F. + FIBERESH OVER 6 MIL. V.B. OVER 6" CRUSHED STONE BASE SEE 8/52.4 FOR SLAB JOINTS

ALTERNATE "A" INCLUDES THE FOLLOWING:  
 1 HOUR METAL STUD & GYPSUM BOARD ENCLOSURE W/ SHAFT WALL AT CEILING AT 10'-0" AFF. ADD CONCRETE FLOOR, PUMP ROOM AND MAN DOOR. WALLS: UL #419 W/ 3/8" METAL STUDS AND 1 LAYER OF GYPSUM BOARD EACH SIDE. CEILING: UL #415 SHAFT WALL SYSTEM (SEE STRUCTURAL FOR FRAMING)

6" 4000 PSI CONCRETE SLAB WITH 6X6 W/2.9W/2.9 W.W.F. + FIBERESH OVER 4" CRUSHED STONE BASE SEE 8/52.4 FOR SLAB JOINTS  
 F.F.E. - (PARTIAL C.I.C.) SEE CIVIL DRAWINGS

**WALL LEGEND**

- W1 EXTERIOR WALL - 8" CMU TO 7'-4" (SPLIT FACE CMU TO 6'-8") METAL PANELS ON METAL BUILDING FRAME ABOVE CMU WALL. 1-1/2" HAT MIN. ABOVE CEILING
- W2 1 HR RATED, UL # U419 WALL - 8" CMU TO 8'-0" GYP. BO. TO DECK ABOVE. (UL#419)
- W3 1 HR RATED, UL # U419 WALL - 8" CMU TO 8'-0" GYP. BO. TO DECK ABOVE. (UL#419)
- W4 1 HR RATED WALL - 8" CMU TO 8'-0" (UL#907) W/ 8" METAL STUDS W/ 5/8" GYP. BO. TO DECK ABOVE. (UL#419)
- W5 1 HR RATED WALL - 8" CMU TO 8'-0" (UL#907) W/ 8" METAL STUDS W/ 5/8" GYP. BO. TO DECK ABOVE. (UL#419)
- W6 1 HR RATED WALL - 8" CMU TO 8'-0" (UL#907) W/ 8" METAL STUDS W/ 5/8" GYP. BO. TO DECK ABOVE. (UL#419)
- W7 1 HR RATED WALL - 8" CMU TO 8'-0" (UL#907) W/ 8" METAL STUDS W/ 5/8" GYP. BO. TO DECK ABOVE. (UL#419)
- W8 1 HR RATED WALL - 8" CMU TO 8'-0" (UL#907) W/ 8" METAL STUDS W/ 5/8" GYP. BO. TO DECK ABOVE. (UL#419)
- W9 1 HR RATED WALL - 8" CMU TO 8'-0" (UL#907) W/ 8" METAL STUDS W/ 5/8" GYP. BO. TO DECK ABOVE. (UL#419)

**KEY NOTES**

1. STEEL BENT - BY MTL. BLDG. MFR.
2. STEEL SUPPORT COL. - BY MTL. BLDG. MFR.
3. STEEL SUPPORT COL. - BY MTL. BLDG. MFR. SEE 4/A3.2 FOR COLUMN PROTECTION.
4. STEEL WIND COL. - BY MTL. BLDG. MFR.
5. BOLLARD - SEE 5/A3.2 TYPICAL. EITHER SIDE OF OVERHEAD DOORS

**GENERAL NOTES**

1. DIMENSIONS SHOWN ARE TO THE FACE OF CMU, BLOCK AND/OR FACE OF STEEL FRAMING.
2. REFER TO CIVIL DRAWINGS FOR SIDEWALKS & CURB INFORMATION.
3. TENANT WILL PROVIDE FIRE EXTINGUISHER IN ACCORDANCE WITH NFPA 101, 2009 EDITION. LOCATION TO BE COORDINATED WITH LOCAL CODE OFFICIAL. AS DESIGNATED BY (S) SYMBOL.
5. BOLLARD - SEE 5/A3.2 TYPICAL. EITHER SIDE OF OVERHEAD DOORS

**THE Hollingsworth Companies**  
 Industrial Building Program  
 Todd Carlin, P.E.  
 Clinton, TN 37716  
 Phone: (666) 457-3801  
 Web: www.hollingsworthco.com

**JE HODGE ASSOCIATES, LLC**  
 ENGINEERS - ARCHITECTS  
 1597 Western Avenue  
 Knoxville, TN 37921-6318  
 Phone: (865) 548-2322

Moving Your Vision Forward  
 Seal: [Professional Engineer Seal for Robert W. Hodge, No. 072316, State of Tennessee, expires 12/31/16]

Issue / Revision	No.	Date	Description
GENERAL REVISIONS	1	07/31/16	GENERAL REVISIONS
OWNER REVISIONS	2	08/05/16	OWNER REVISIONS
OWNER REVISIONS	3	09/10/16	OWNER REVISIONS

Approved For Construction: \_\_\_\_\_ Date: \_\_\_\_\_  
 Purchaser: \_\_\_\_\_ Date: \_\_\_\_\_  
 Owner: \_\_\_\_\_ Date: \_\_\_\_\_  
 Hollingsworth Job No.: TA-162-13  
 Hodge Project No.: 14102

Drawn By: \_\_\_\_\_  
 Eng Check: \_\_\_\_\_ Dept Check: \_\_\_\_\_ QA Check: \_\_\_\_\_

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Project Title: **Hollingsworth Companies**  
 126,000 sq. ft.

Location: Lot 2, 1545 Mountain Road  
 Andersonville, Tennessee 37705

**FLOOR PLAN**

Sheet Comments:  
 Date: **18 March, 2014**  
 Sheet Number: **A1.1**  
 1 OF 13